

1 ELEVATION  
3/8" = 1'-0"




2 ELEVATION  
3/8" = 1'-0"

NOTE: ATTACH T & G DECKING TO BEAMS W/ (2) SIMPSON SDS SCREWS, 3" LONG, STAGGER @ EA. BEAM. NAIL PLYWOOD DECKING TO T & G W/ 8d DECK NAILS @ 6" O.C. PERIMETER EACH SHEET, 12" O.C. LONG, @ 15" LAT. IN FIELD.

NOTE:  
1. ALL GLULAM BEAMS SHALL BE DF/DF 24F-V4 W/ SEALED END AND WATER RESISTANT GLUE RESEAL. ALL CUT SURFACES PRIOR TO INSTALLATION.  
2. ALL 6 X 6 POSTS SHALL BE DF #1 MATERIAL.  
3. ALL 6 X 8 POSTS SHALL BE DF DENSE #1 MATERIAL.

DESIGN LOADS:  
ROOF ..... 185 PSF  
WIND ..... 90 MPH EXPOSURE 'C'  
SEISMIC ..... SITE CLASS 'D', SDS = 0.551, SDI = 0.293  
MINIMUM ALLOWABLE PRESSURE 1,500 PSF


3 SECTION  
3/8" = 1'-0"

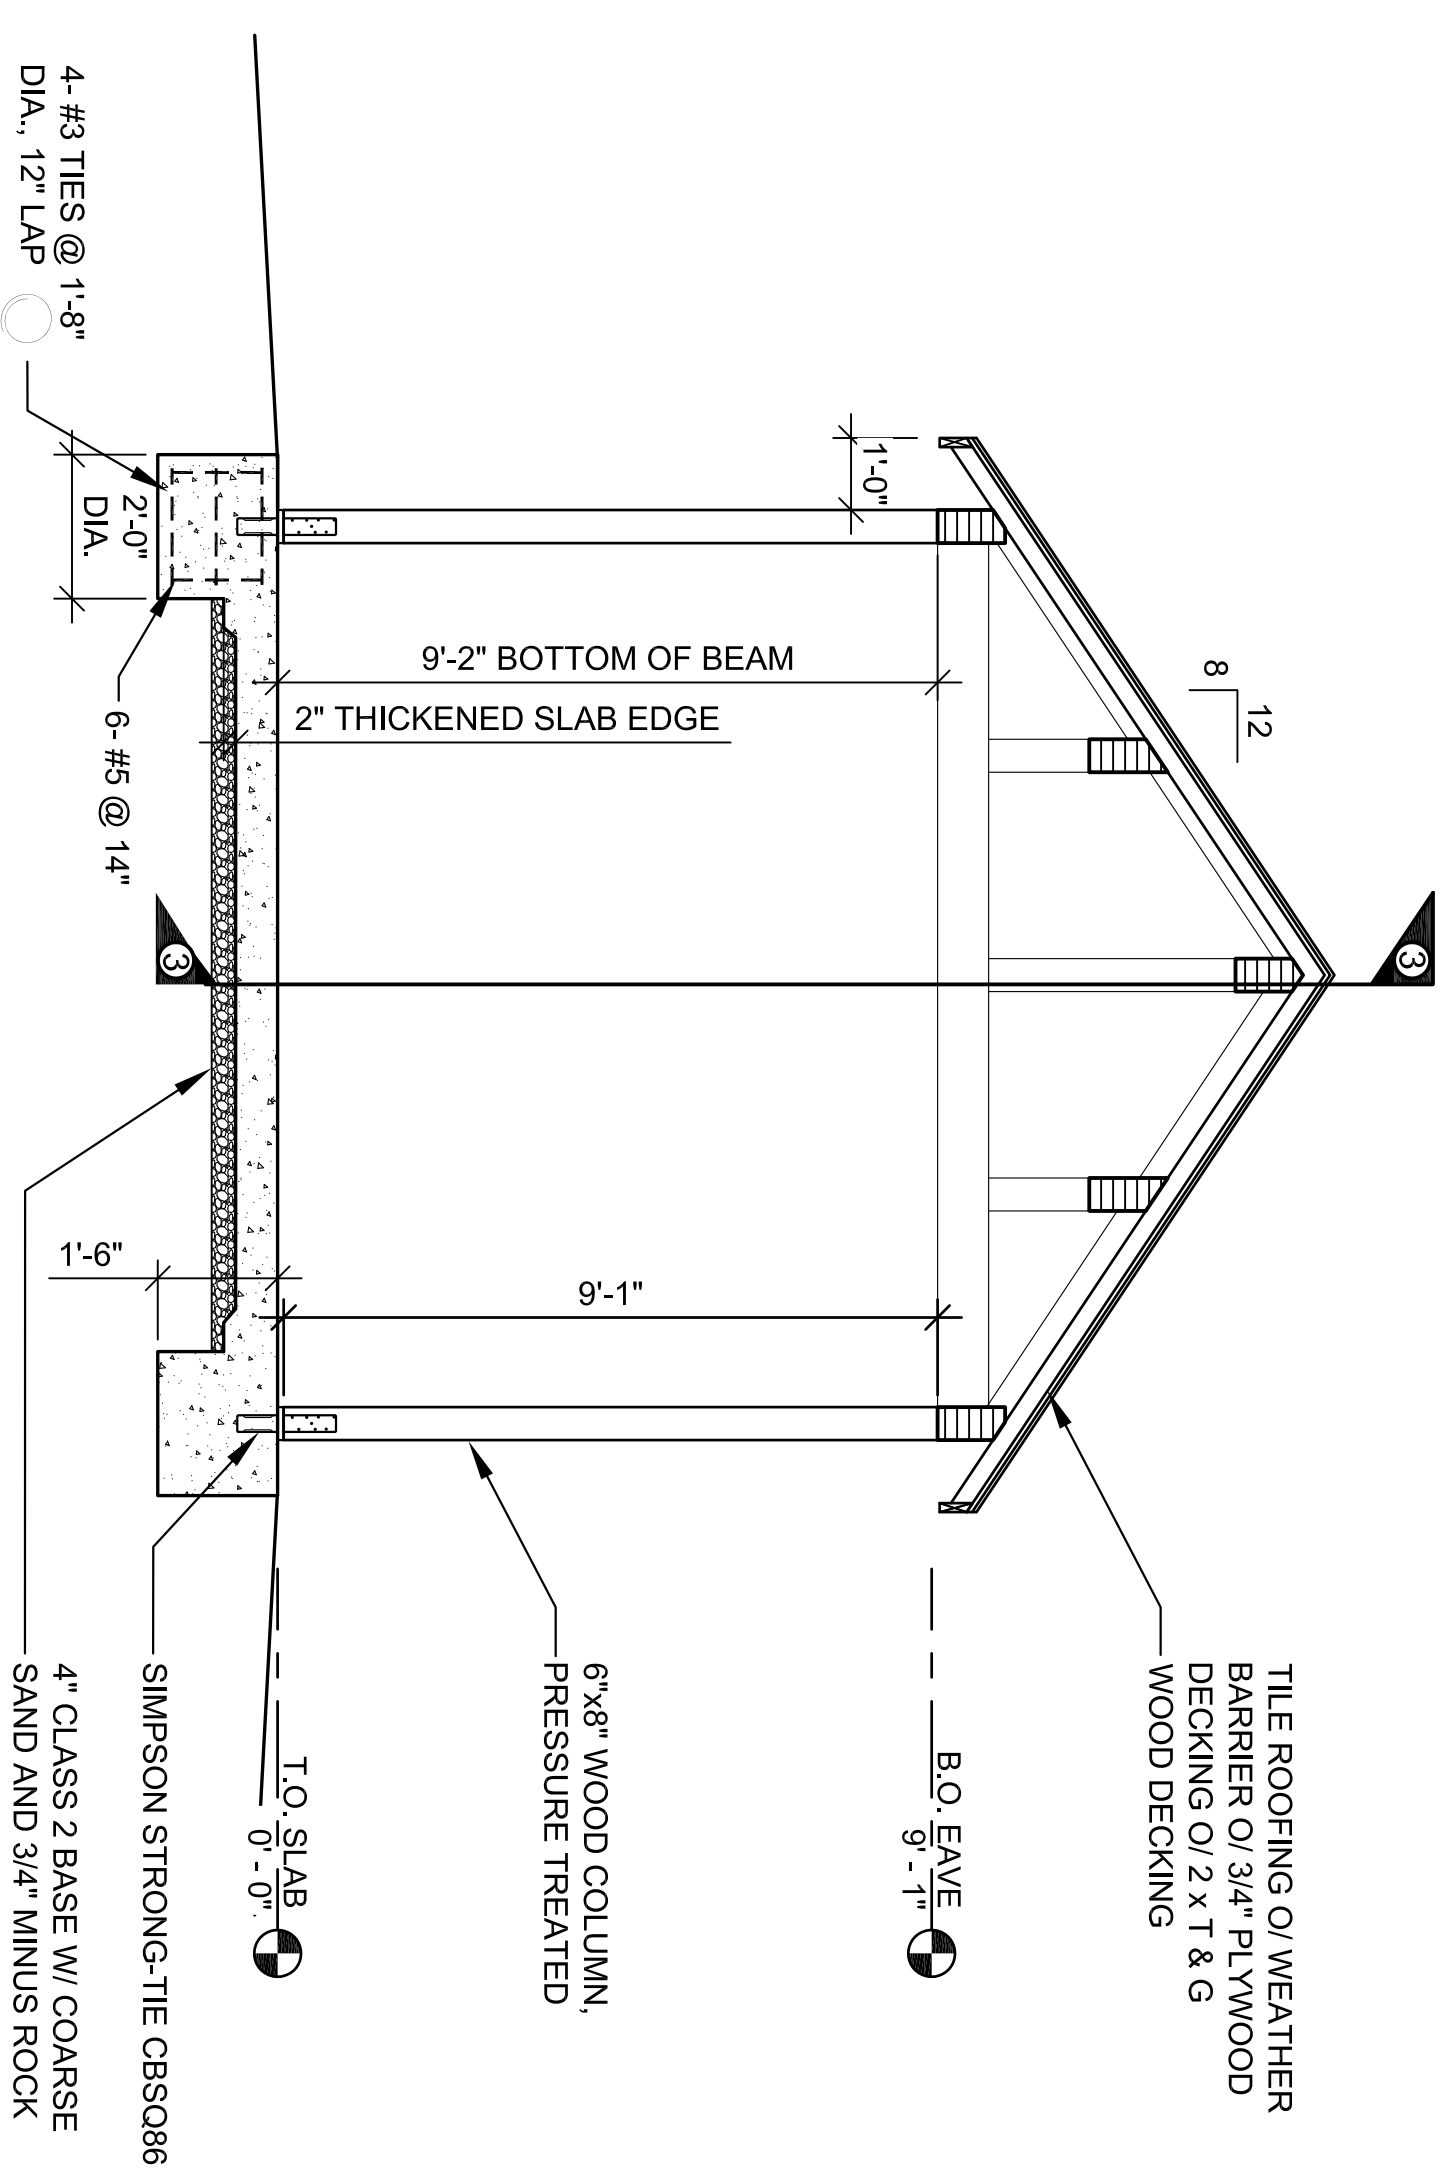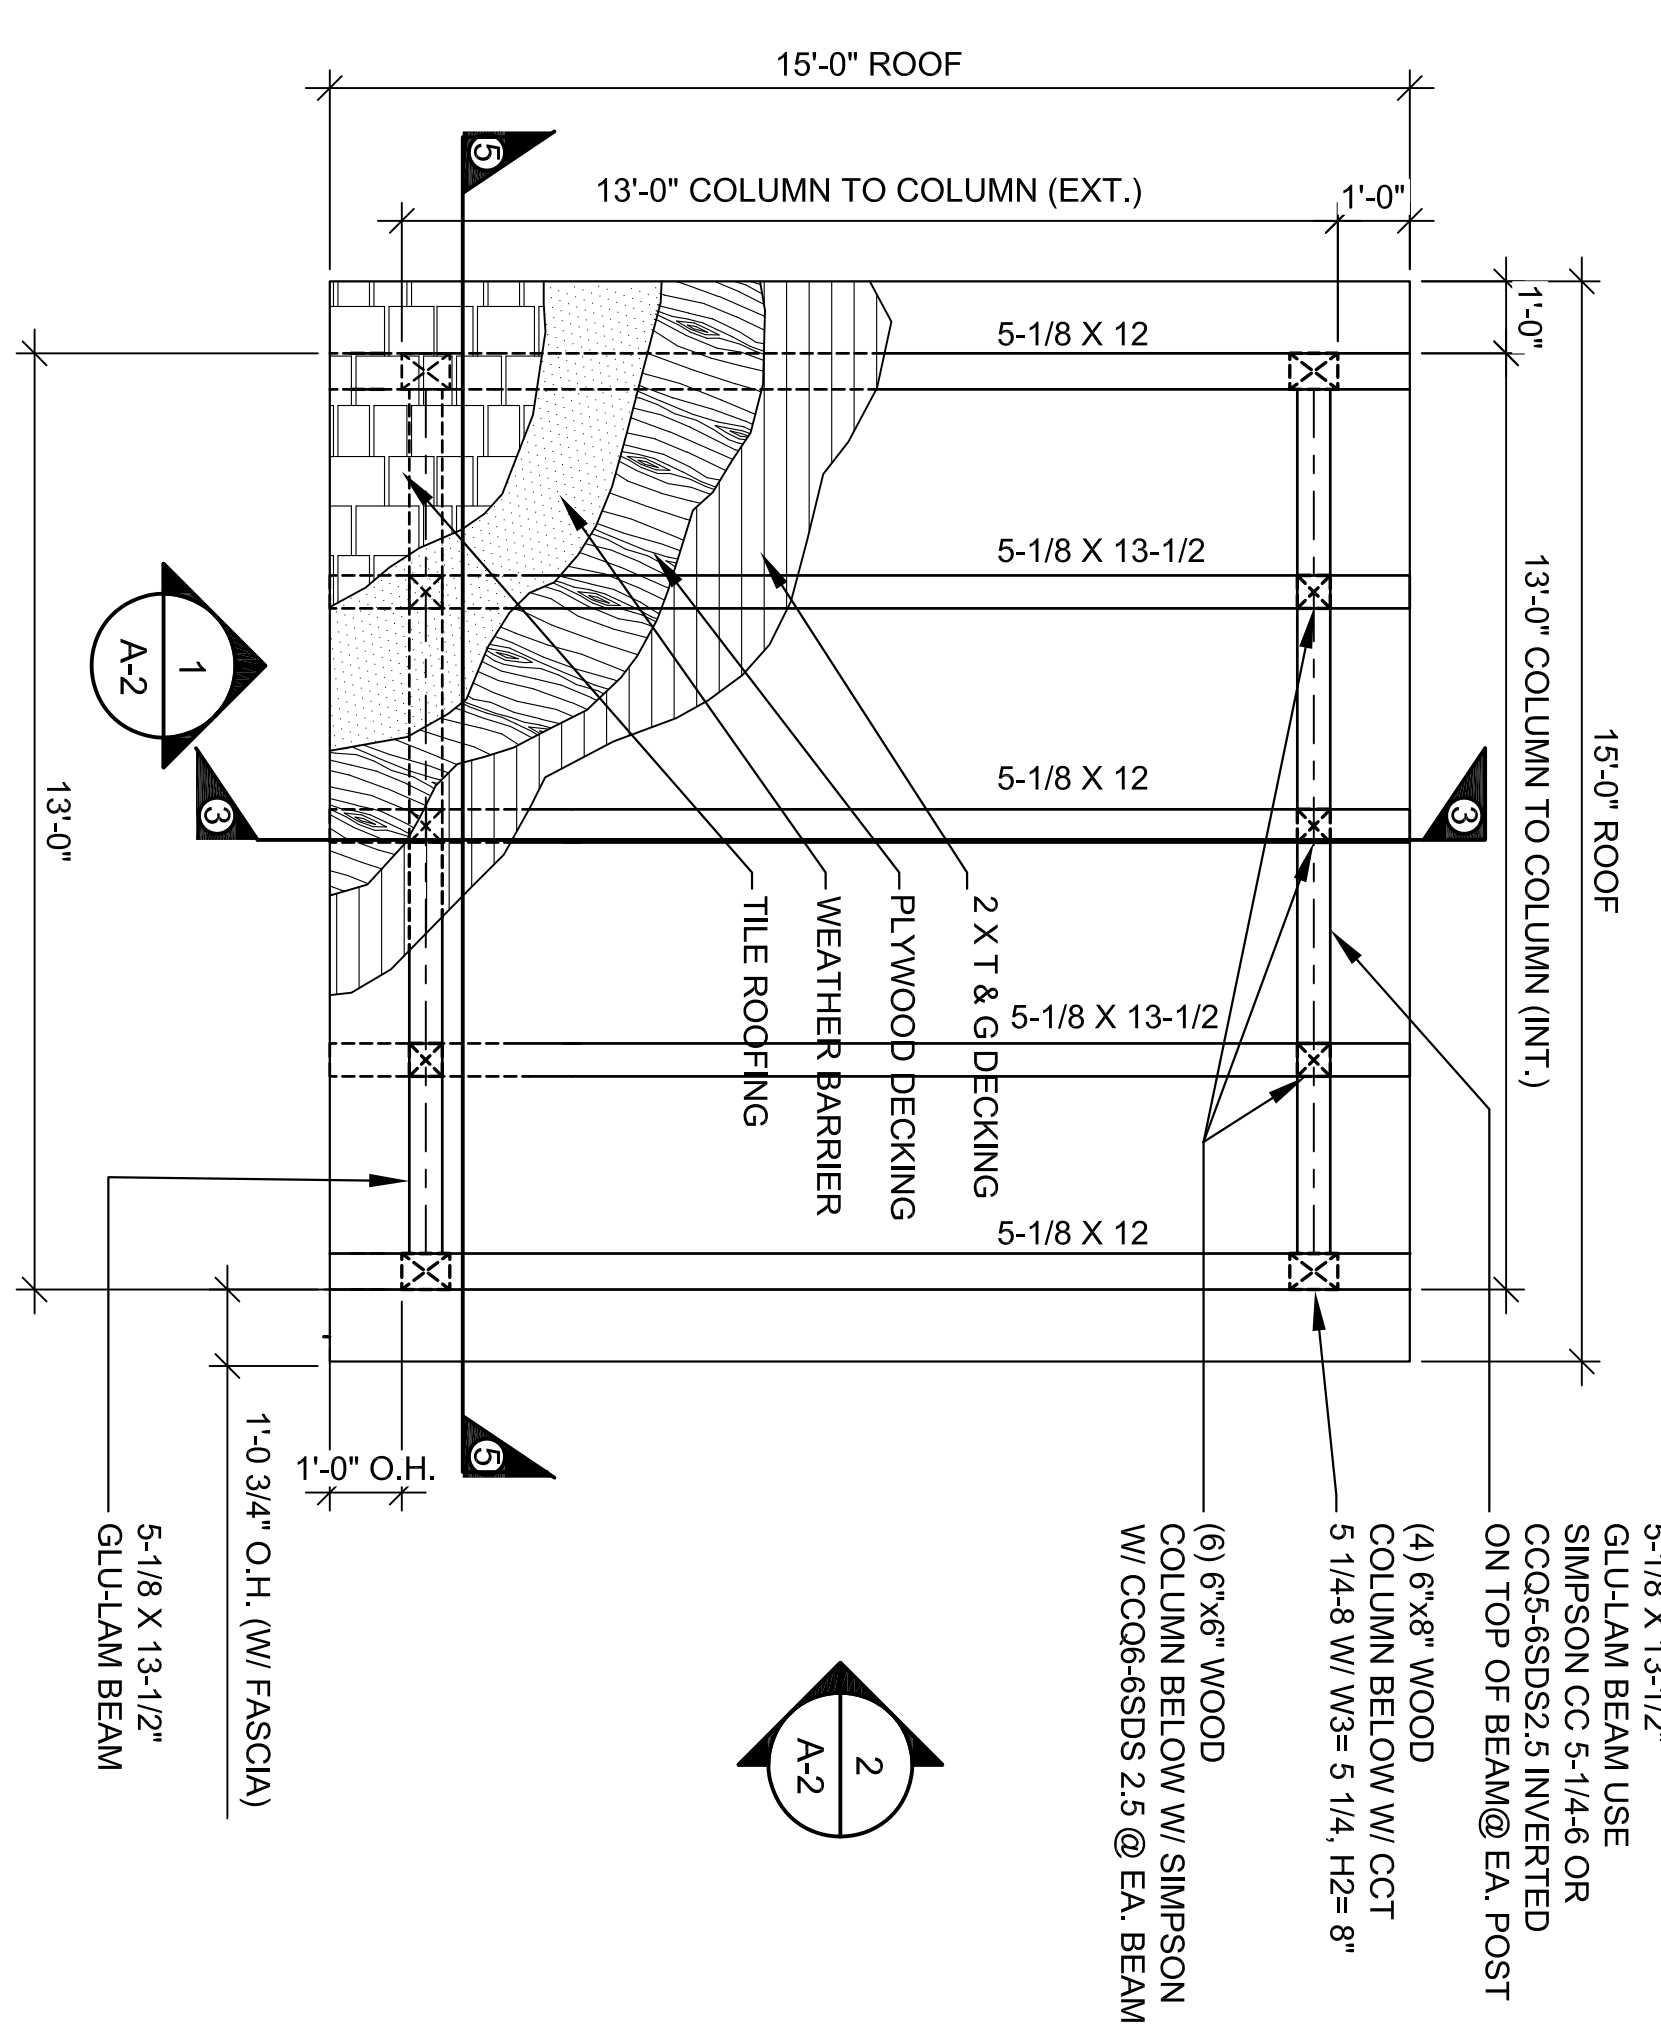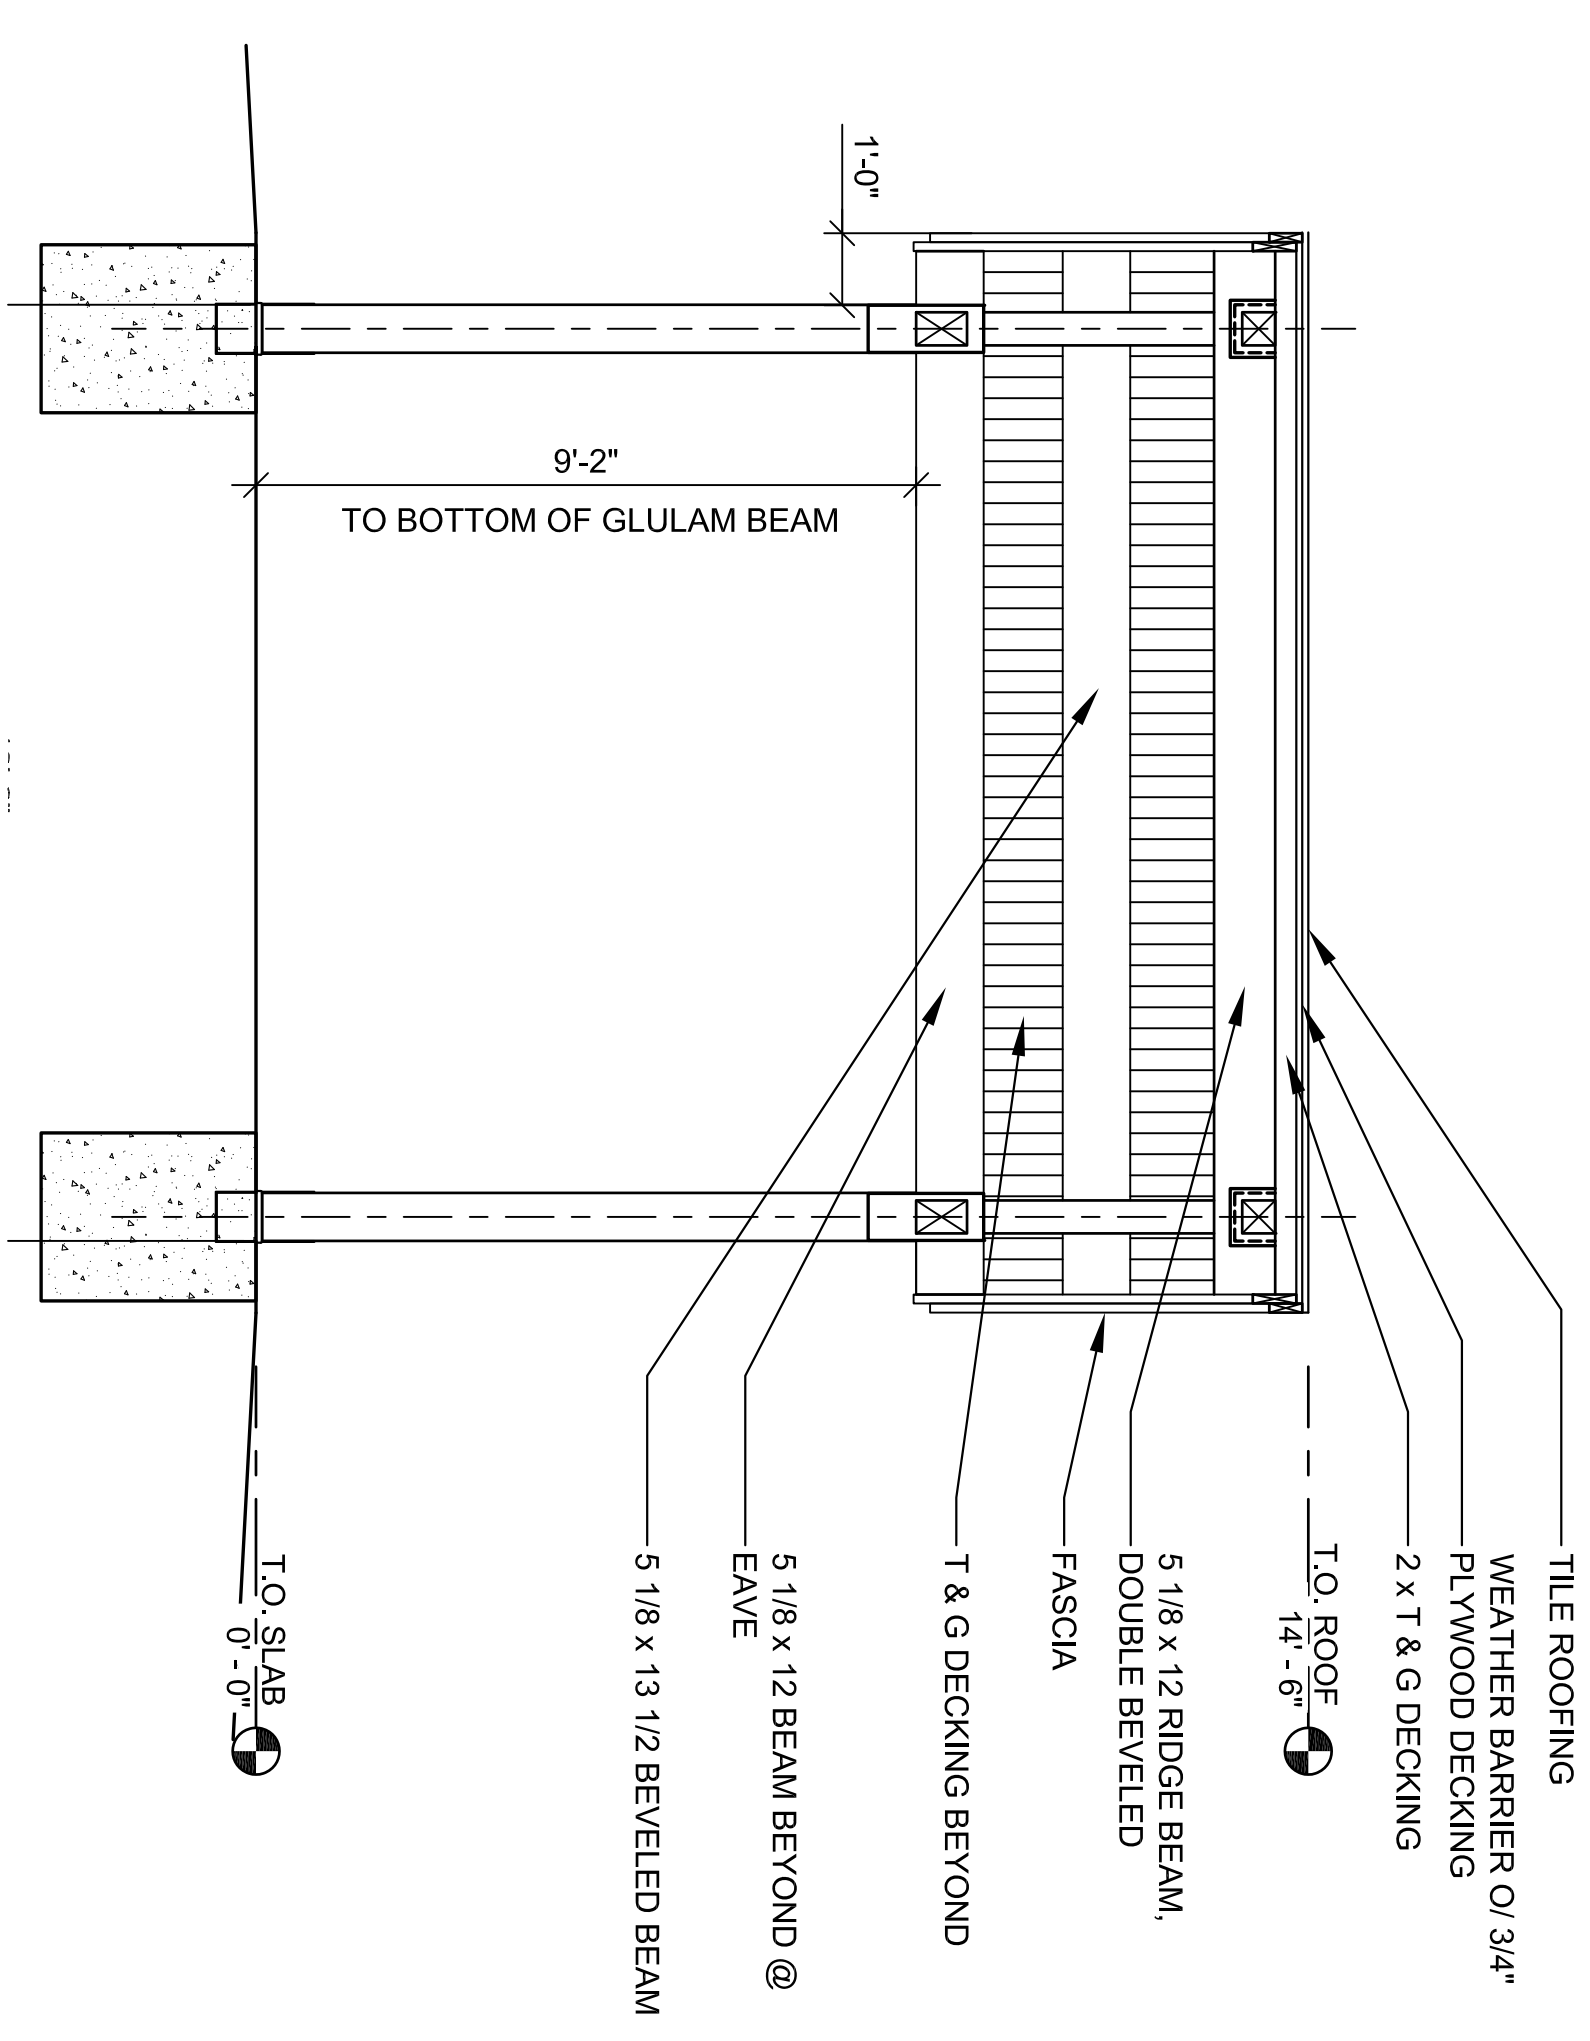

4 FRAMING PLAN  
3/8" = 1'-0"


5 SECTION  
3/8" = 1'-0"

6 SLAB PLAN  
3/8" = 1'-0"

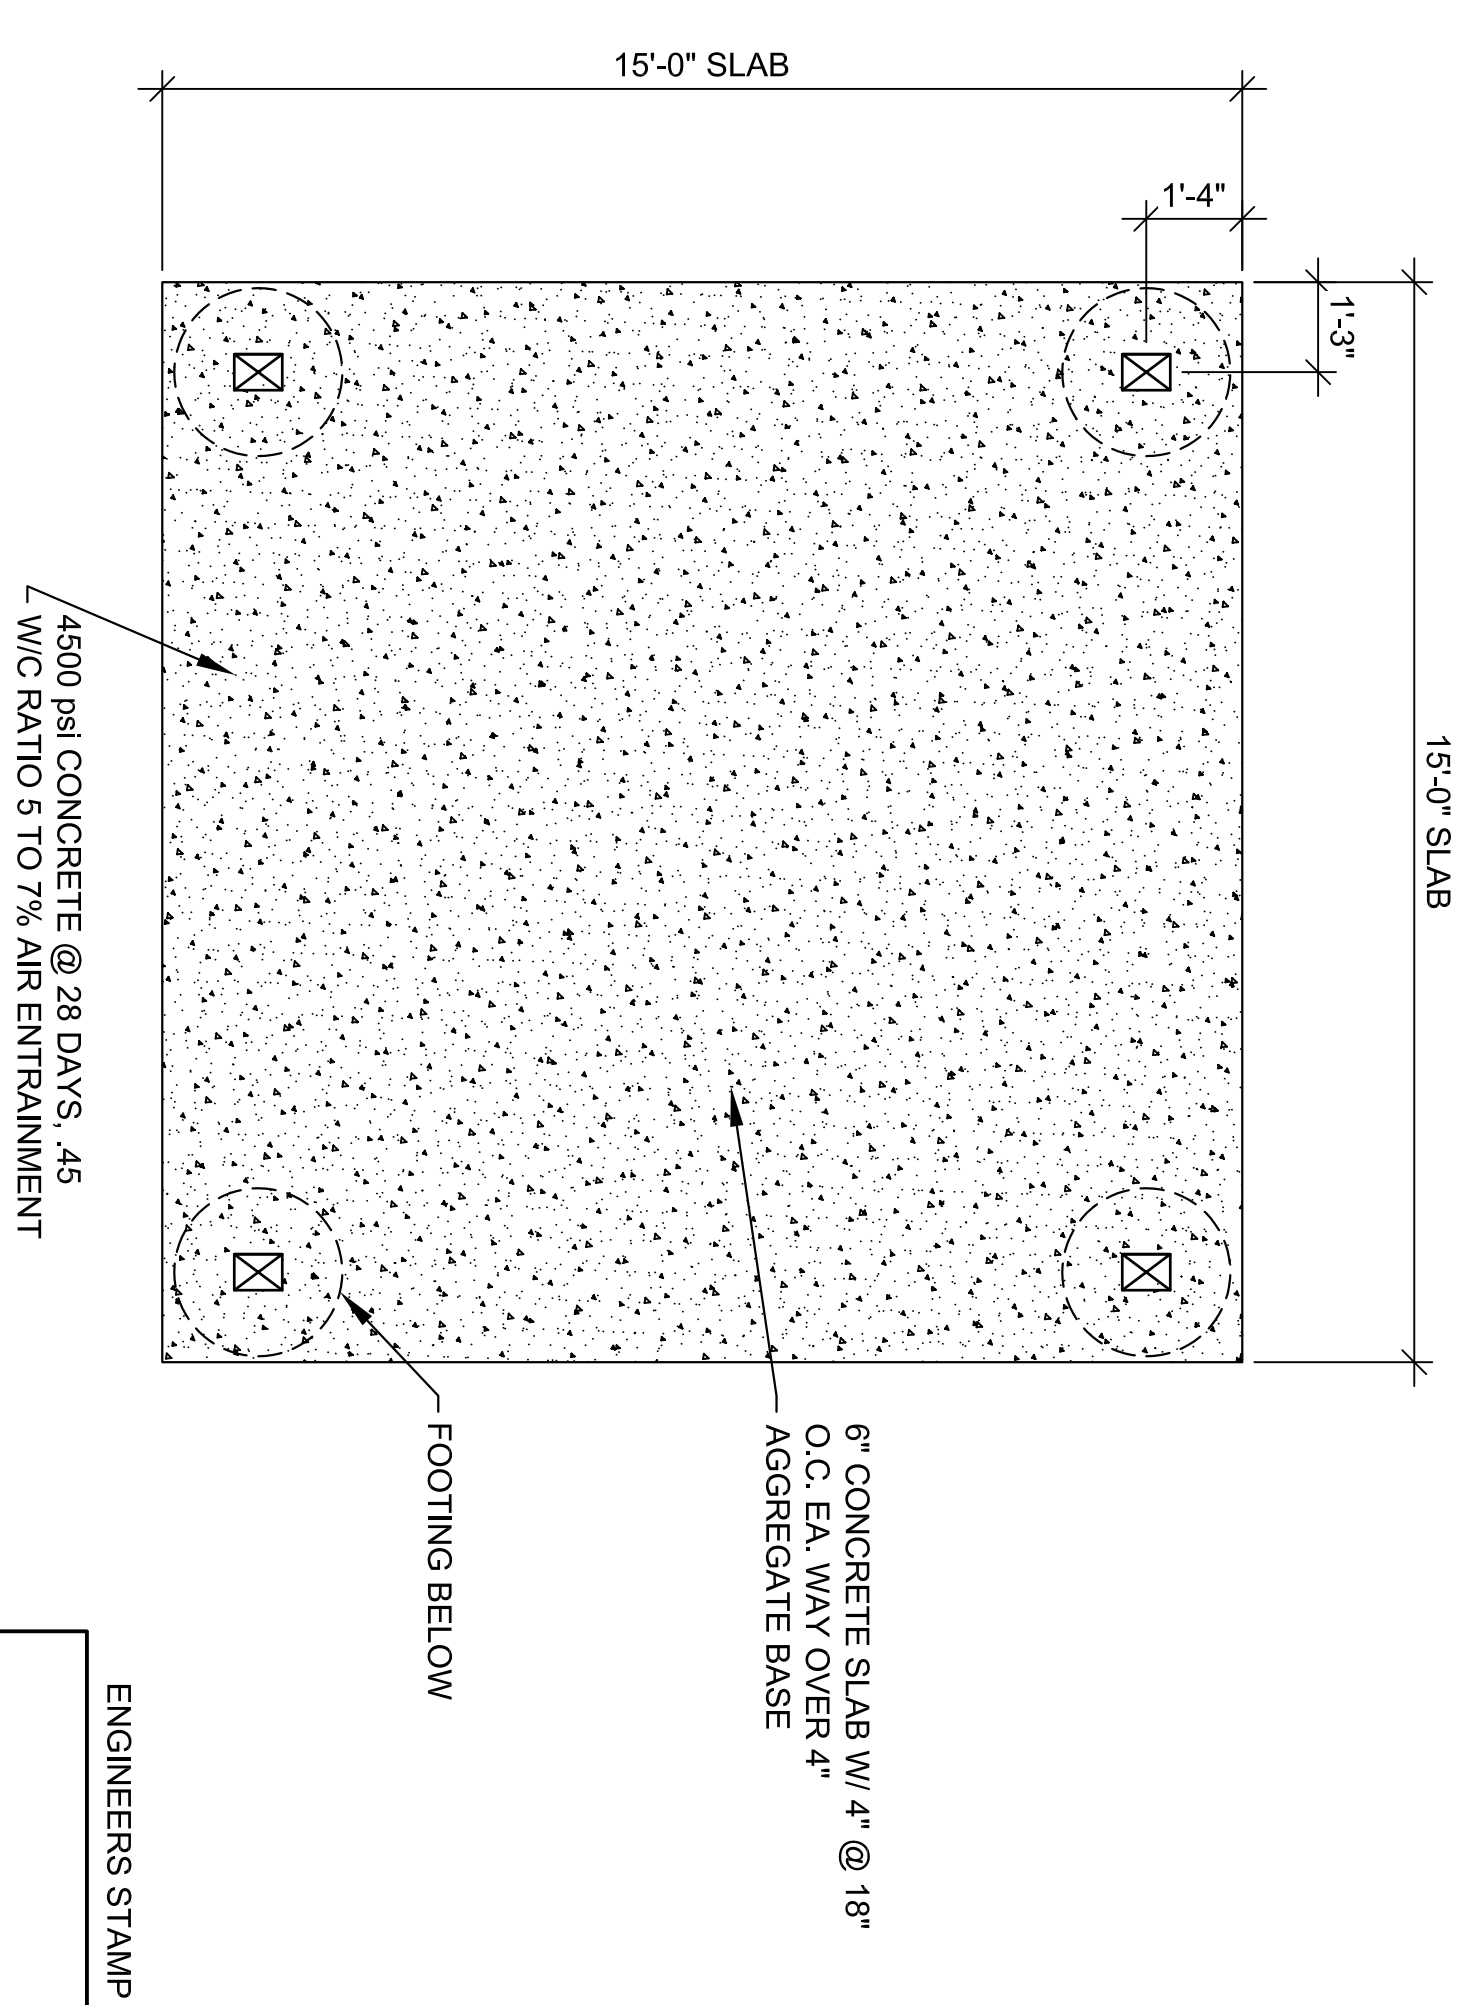

No.	Description	Date

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PROJECT ARCHITECT:  
**USDA Forest Service**

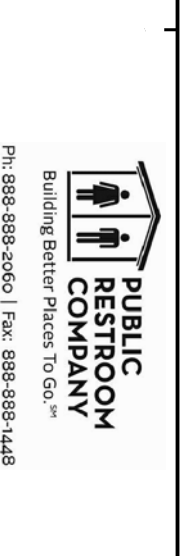PROJECT OWNER:  
**USDA Forest Service**

PROJECT NAME AND LOCATION:  
**Pinecrest West Day Use Area - Fish Cleaning Station/ Pavillion Pinecrest Basin, CA**

SHEET TITLE:  
**Floor Plan, Elevations**

Drawn by: **KJM** Job No. **8845**  
Checked by: **CEK**  
Current Date: **12/26/2012**  
Sheet Date: **12/24/2012**